# PREPARE ROOF FOR NEW CANOPY SYSTEM TO TIE INTO EXISTING CANOPY ROOF AND **FASCIA** PREPARE EXISTING CANOPY, BUILDING ENVELOPE, AND INTERIOR PARTITIONS FOR PNEUMATIC TUBE SYSTEM —DEMOLISH WALL, LEAVE ENOUGH FOR SOFFIT FOR EXISTING CEILING SYSTEM TO CONNECT TO FOR NEW DOOR CLASSROOM CLASSROOM MECHANICAL \_CLASSROOM` [503 ] REMOVE WALL, DOOR -REF. FLOOR PLAN 101 ELECTRICAL CLOSET 901 — CONFERENCE \_\_CENTER REF. FLOOR PLAN FOR NEW DOOR, —WALL TO REMAIN, TYP. REF. FLOOR PLAN —ACOUSTIC CEILING TILE SYSTEM TO REMAIN, EXISTING LIGHTING TO REMAIN UNLESS STUDENT CHAIRS & OTHERWISE NOTED, TYP. -TABLES -RESOURCE | | 204 | LIGHTING WITH NEW CLASSROOM ROUGH OPENING FOR NEW DOOR, REF. FLOOR PLAN \_RESTROOM L601 JANITORIAL WOMEN'S \_\_RESTROOM |L602 ]| 502B

REFLECTED CEILING PLAN

1/8" = 1'-0"


A011



EXISTING TO REMAIN EXISTING TO BE DEMOLISHED NEW CONSTRUCTION

### **GENERAL NOTES - NEW WORK**

OUTSIDE OF DOOR JAMB ROUGH OPENINGS TO BE 3" FROM WALL INTERSECTIONS UNLESS OTHERWISE INDICATED. PROVIDE BLOCKING FOR KITCHEN, BATHROOM AND FUTURE ADA ACCESSORIES DIMENSIONS ARE TO FACE OF STUD LAYER UNLESS OTHERWISE INDICATED. ALL WALL FINISHES ARE TO MATCH EXISTING. ALL EXISTING FLOOR FINISHES ARE TO BE CONTINUOUS UNDER NEW PARTITIONS. NEW WALL FINISHES AND WALLBASES ARE TO MATCH EXISTING CONDITIONS. ELETRICAL OUTLETS TO BE CENTERED AND SPACED EQUAL ON DESIGNATED WALLS. COORDINATE LIGHT CONTROLS & SWTICHES WITH OWNERSHIP.

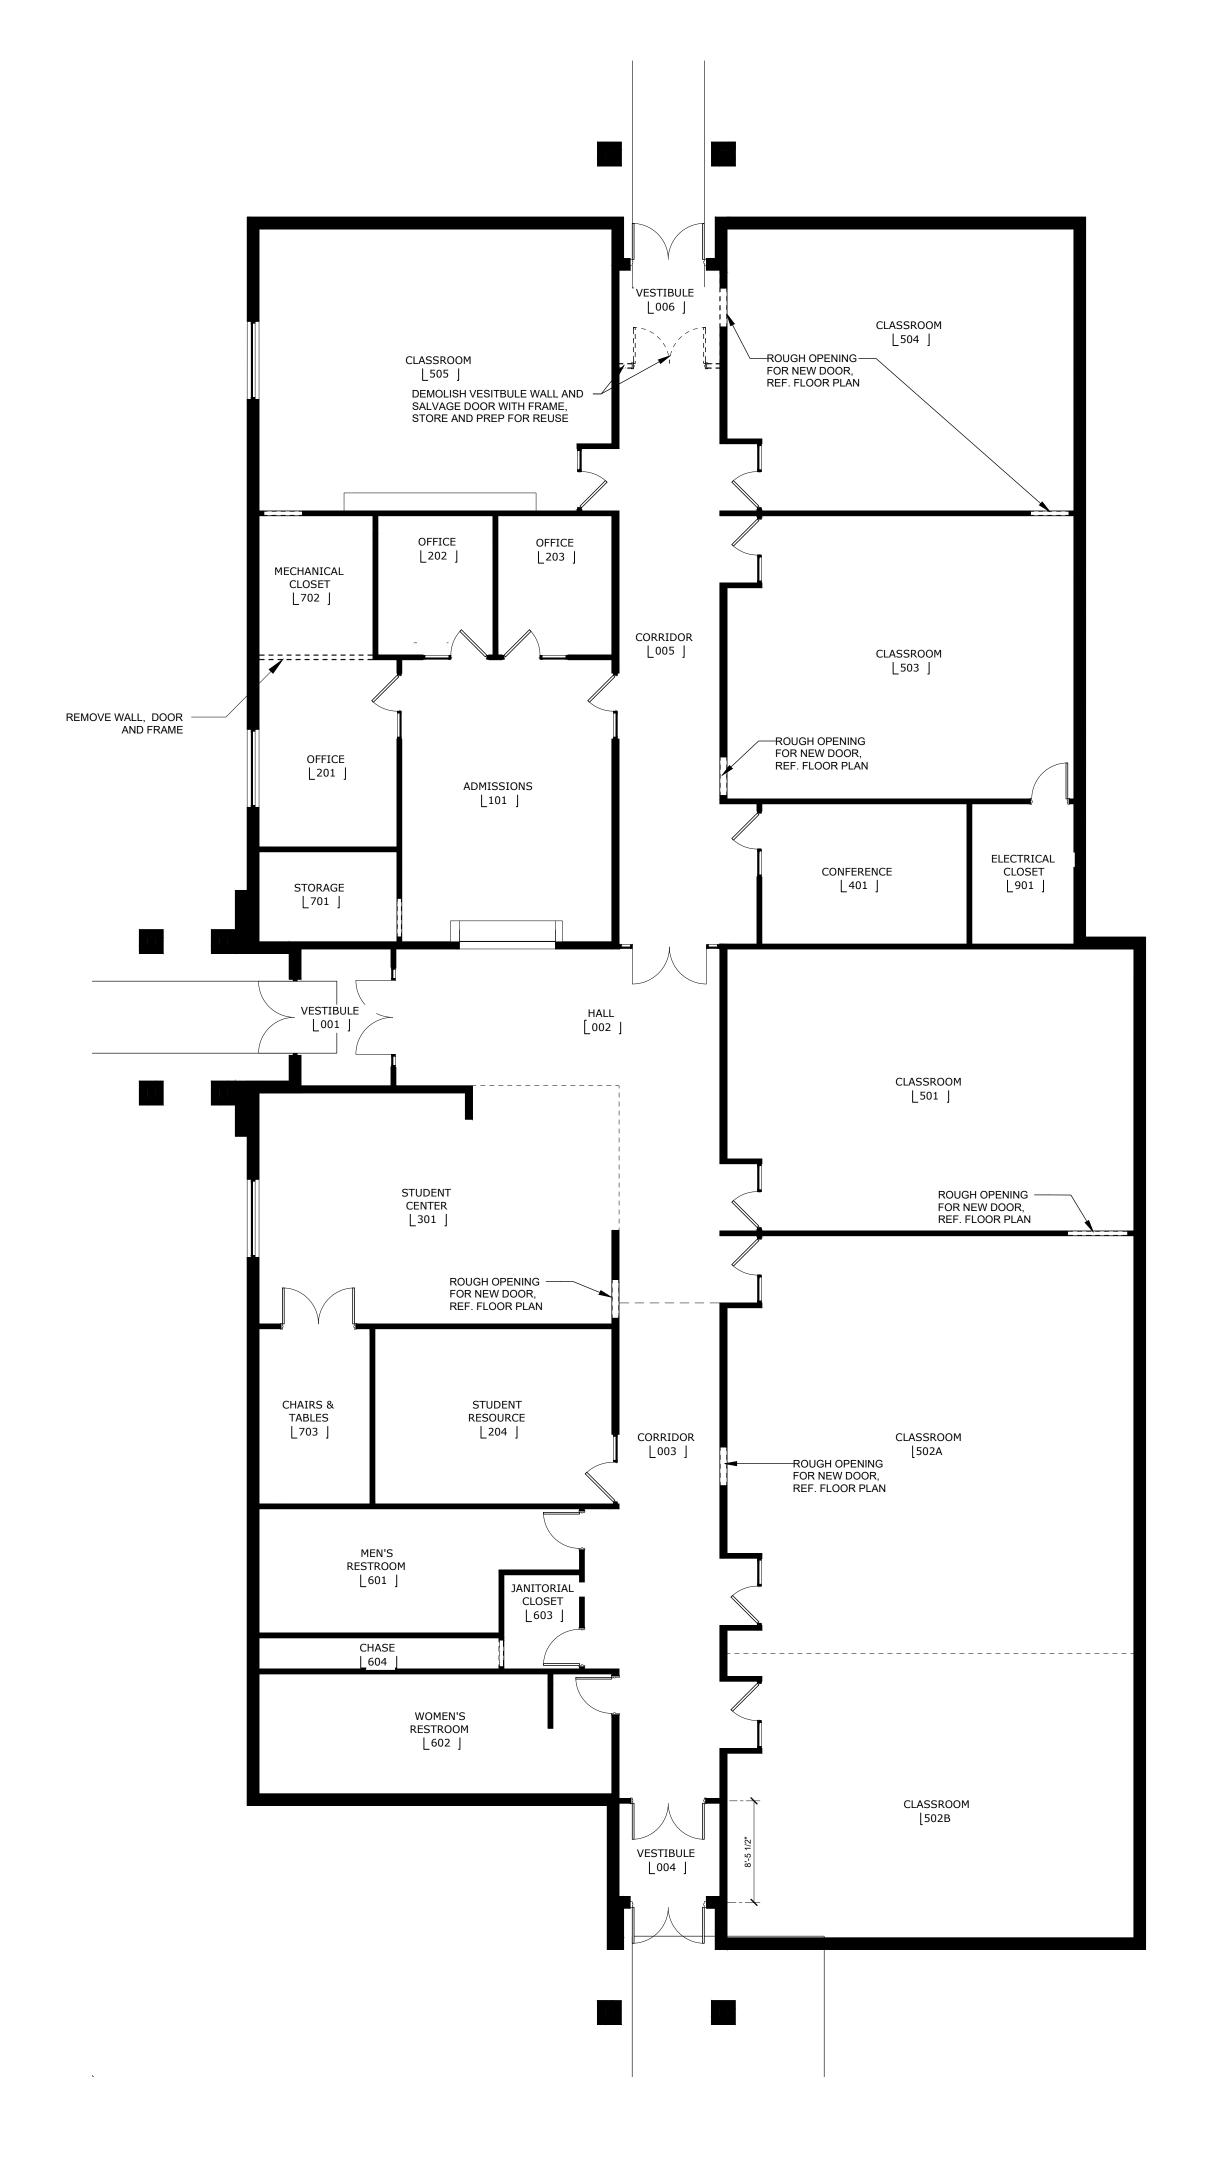






EDMONDSON DESIGN GROUP, INC. 8263 South Harvard, Suite 224 Tulsa, Oklahoma 74137 T: 918.576.6700 This document, and the ideas and designs incorporated herein, as an instrument of professional service, is the property of EDMONDONS DESIGN GROUP, INC. and is not to be used, in whole

or in part, for any other project, without the written authorization of EDMONDONS DESIGN GROUP, INC. .

CITY OF GROVE

CITY OFFICES


**ARCHITECTURE & INTERIOR DESIGN** Edmondson Design Group 8263 South Harvard Avenue, Suite 224 Tulsa, Oklahoma 74137 T: 918.576.6700

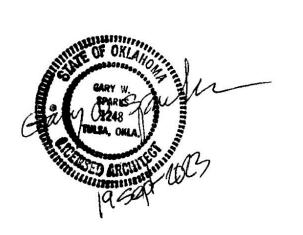



CONSTRUCTION DOCUMENTS

A011 As indicated

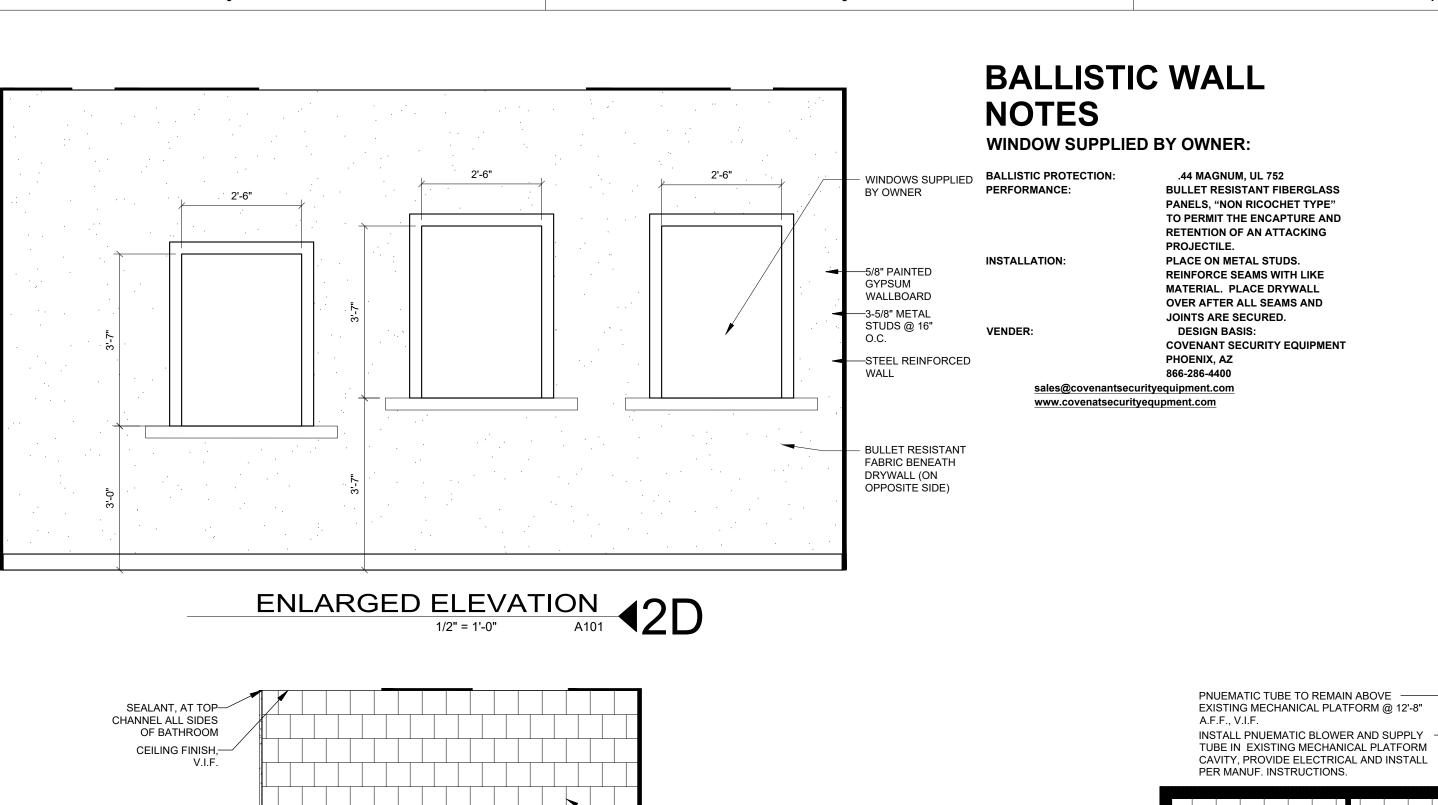

DISPENSER — TO BOTTOM OF DISPENSER OUTLET

NOTE:

## **GENERAL NOTES:**

- PROJECT IS MODIFICATION OF EXISTING INTERIOR SPACE AND
- ADDITION OF CANOPY OVER EXISTING WALKWAY. VERIFY CONDITIONS PRIOR TO DEMOLITION. CONTACT ARCHITECT IF EXISTING CONDITIONS CONFLICT WITH DOCUMENTS.
- MATCH ADJACENT SURFACES WITH WALL ADDITIONS, FILL INS, EXTENSIONS, ETC. PAINT ENTIRE WALL WHERE POSSIBLE TO MINIMIZE TEXTURE AND COLOR DIFFERENCES.
- PNEUMATIC TUBE SYSTEM, INCLUDING ALL EQUIPMENT AND LABOR TO INSTALL, IS BY OTHERS. CONTRACTOR AND SYSTEM SUPPLIER COORDINATE SYSTEM'S ELECTRICAL REQUIREMENTS AND EXISTING SURFACE DAMAGED BY SYSTEM INSTALLATION.

## **OPENING SCHEDULE**

- 1, 2, 5, 6\*, 3'X7'X134" SOLID CORE WOOD DOOR IN HOLLOW METAL
- AND FINISH.
- 3'X7'X134" SOLID CORE WOOD DOOR IN HOLLOW METAL FRAME, ADA COMPLIANT RESTROOM LOCKSET. MATCH EXISTING DOORS' VENEER AND FINISH.
- CLOSET LOCKSET. MATCH EXISTING DOORS' VENEER AND FINISH.
- REPLACE IF NON COMPLIANT.
- 3'X7'X11/4" BI-FOLD WOOD DOOR, WOOD FRAME. MATCH EXISTING DOORS' VENEER

#### **GENERAL NOTES-RCP**

- EXISTING TROFFER LIGHTING TO BE RELOCATED AND SPACED EVENLY AND CENTERED ON ROOM AS NEEDED. DIMENSIONS ARE TO FACE OF STUD LAYER UNLESS OTHERWISE INDICATED.
- PATCH AND REPAIR ACOUSTIC CEILING GRID SYSTEM WITH MATCHING MATERIALS AS NECESSARY. PARTIAL HEIGHT WALLS TO REMAIN 24" FREE AND CLEAR FOR ADEQUATE FLOW OF AIR. ACOUSTIC INSULATION IS OPTIONAL OVER RESTROOMS.
- RELOCATE EXISTING LIGHTING TO BE EQUALLY CENTERED ON NEW SPACES. REPAIR AND REPLACE CEILING TILE AND GRID AS NECESSARY.

#### PROVIDE BLOCKING FOR KITCHEN, BATHROOM AND FUTURE ADA ACCESSORIES

COORDINATE LIGHT CONTROLS & SWTICHES WITH OWNERSHIP.

**GENERAL NOTES - NEW WORK** 

OUTSIDE OF DOOR JAMB ROUGH OPENINGS TO BE 3" FROM WALL INTERSECTIONS UNLESS OTHERWISE INDICATED. DIMENSIONS ARE TO FACE OF STUD LAYER UNLESS OTHERWISE INDICATED. ALL WALL FINISHES ARE TO MATCH EXISTING. ALL EXISTING FLOOR FINISHES ARE TO BE CONTINUOUS UNDER NEW PARTITIONS. NEW WALL FINISHES AND WALLBASES ARE TO MATCH EXISTING CONDITIONS. ELETRICAL OUTLETS TO BE CENTERED AND SPACED EQUAL ON DESIGNATED WALLS.

OUTLET



EDMONDSON DESIGN GROUP, INC. 8263 South Harvard, Suite 224 Tulsa, Oklahoma 74137 T: 918.576.6700 This document, and the ideas and designs incorporated herein, as an instrument of professional service, is the property of EDMONDONS DESIGN GROUP, INC. and is not to be used, in whole

or in part, for any other project, without the written authorization of

EDMONDONS DESIGN GROUP, INC. .

CITY OFFICES

Edmondson Design Group

8263 South Harvard Avenue, Suite 224

Tulsa, Oklahoma 74137 T: 918.576.6700

**ARCHITECTURE & INTERIOR DESIGN** 

CITY OF GROVE


NEW CONSTRUCTION

PHASING LEGEND

EXISTING TO BE DEMOLISHED

FROM EXISTING

EXISTING TO REMAIN

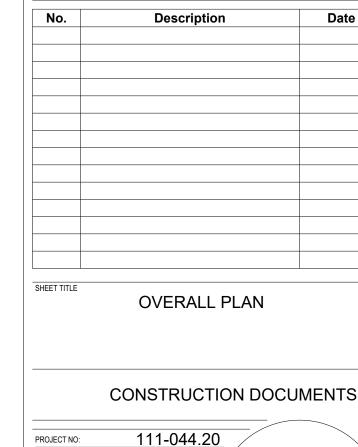

A101

As indicated

# CONSTRUCTION DOCUMENTS 111-044.20

- FRAME, ADA COMPLIANT OFFICE LOCKSET. MATCH EXISTING DOORS' VENEER
- 3'X7'X13/4" SOLID CORE WOOD DOOR IN HOLLOW METAL FRAME, ADA COMPLIANT
- EXISTING DOOR AND FRAME REUSED. VERIFY HW LOCKSET IS ADA COMPLIANT,
- PAIR 3'X7'X13/4" SOLID CORE WOOD DOOR IN HOLLOW METAL FRAME, ADA COMPLIANT RESTROOM LOCKSET. MATCH EXISTING DOORS' VENEER AND FINISH.
- \*FIELD VERIFY FIRE RATED CORRIDOR, IF EXISTING CORRIDOR IS FIRE RATED PROVIDE 45 MINUTE RATED DOOR AND FRAME WITH CLOSER.

NECESSARY

**ENCLOSED ENTRANCE CANOPY** 

ENVELOPE AND FLASH WHERE

PENETRATION TO BUILDING

NOTE - PNUEMATIC TUBING

MEET REQ'D UL RATINGS.

WITHIN PLENUM SPACE SHOULD

**DOOR NOTES:** 

COMPLIANT.

- 1. DOORS SHALL BE READILY OPENABLE FROM THE EGRESS SIDE WITHOUT THE USE OF A KEY OR SPECIAL KNOWLEDGE OR EFFORT (REFER IBC 2018 SECTION 1010.1.9)
- 2. DOOR HANDLES, PULLS, LATCHES, LOCKS AND OTHER OPERATING DEVICES SHALL NOT REQUIRE TIGHT GRASPING, TIGHT PINCHING OR TWISTING OF THE WRIST TO OPERATE.
- (REFER IBC 2018 SECTION 1010.1.9.1) DOOR HARDWARE TO COMPLY WITH ADA. LEVER TYPE LOCKSETS, CLOSER PULL PRESSURE, ETC.
- COORDINATE KEYING WITH OWNER. 5. OPENING DIMENSIONS ON FLOOR PLAN ARE AS FOLLOWS:
- **DOORS:** DIMENSIONS ARE OF DOOR LEAF, FRAMES ARE NOT INCLUDED IN THE DIMENSION. CONTRACTOR COORDINATE FRAME DIMENSION

NOTE - RECOMMEND PUTTING

PNUEMATIC TUBE SYSTEM ON

INDEPENDENT BREAKER OR BREAKER

OF FACILITY OR SOLELY IPACTS GROVE

THAT LEAST IMPACTS PERFORMANCE


PNEUMATIC TUBE STATION TO —

OWNERSHIP, PROVIDE POWER

BE COORDINATE WITH


PER MANUF. REQ.S

WITH DOOR LEAF TO DETERMINE ROUGH OPENING REQUIREMENTS. WINDOWS: DIMENSIONS ARE OF WINDOW'S NOMINAL SIZE, CONTRACTOR COORDINATE WINDOW DIMENSION WITH ROUGH OPENING MATCH EXISTING HARDWARE FINISH AND STYLE (IF EXISTING STYLE IS ADA

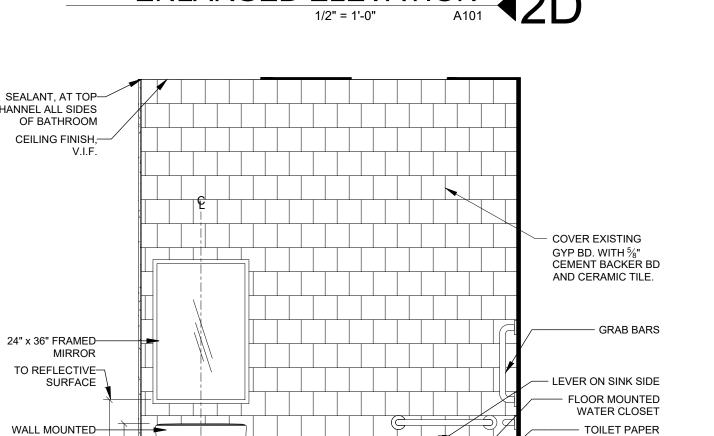

ENLARGED ELEVATION
1/2" = 1'-0" A101 

42C

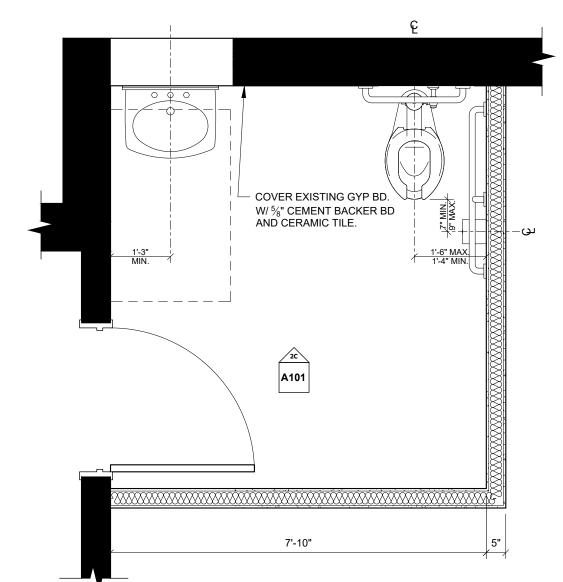



LAVATORY


WALL BASE, MATCH

SEALANT, AT-BOTTOM CHANNEL ALL SIDES OF

ENLARGED PLAN
1/2" = 1'-0"
A101

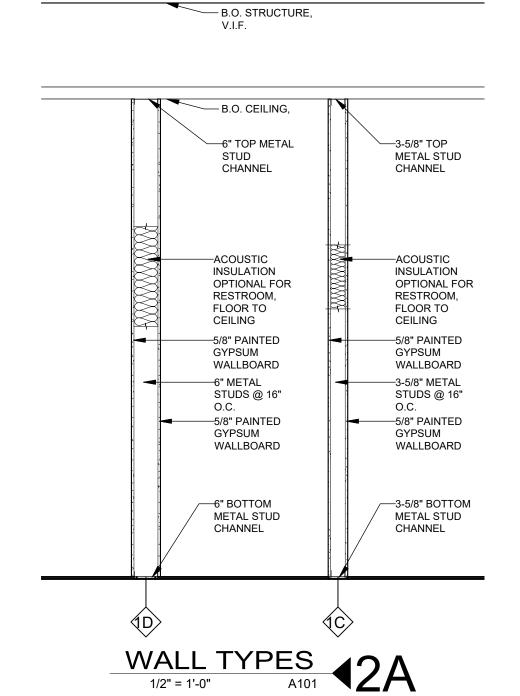

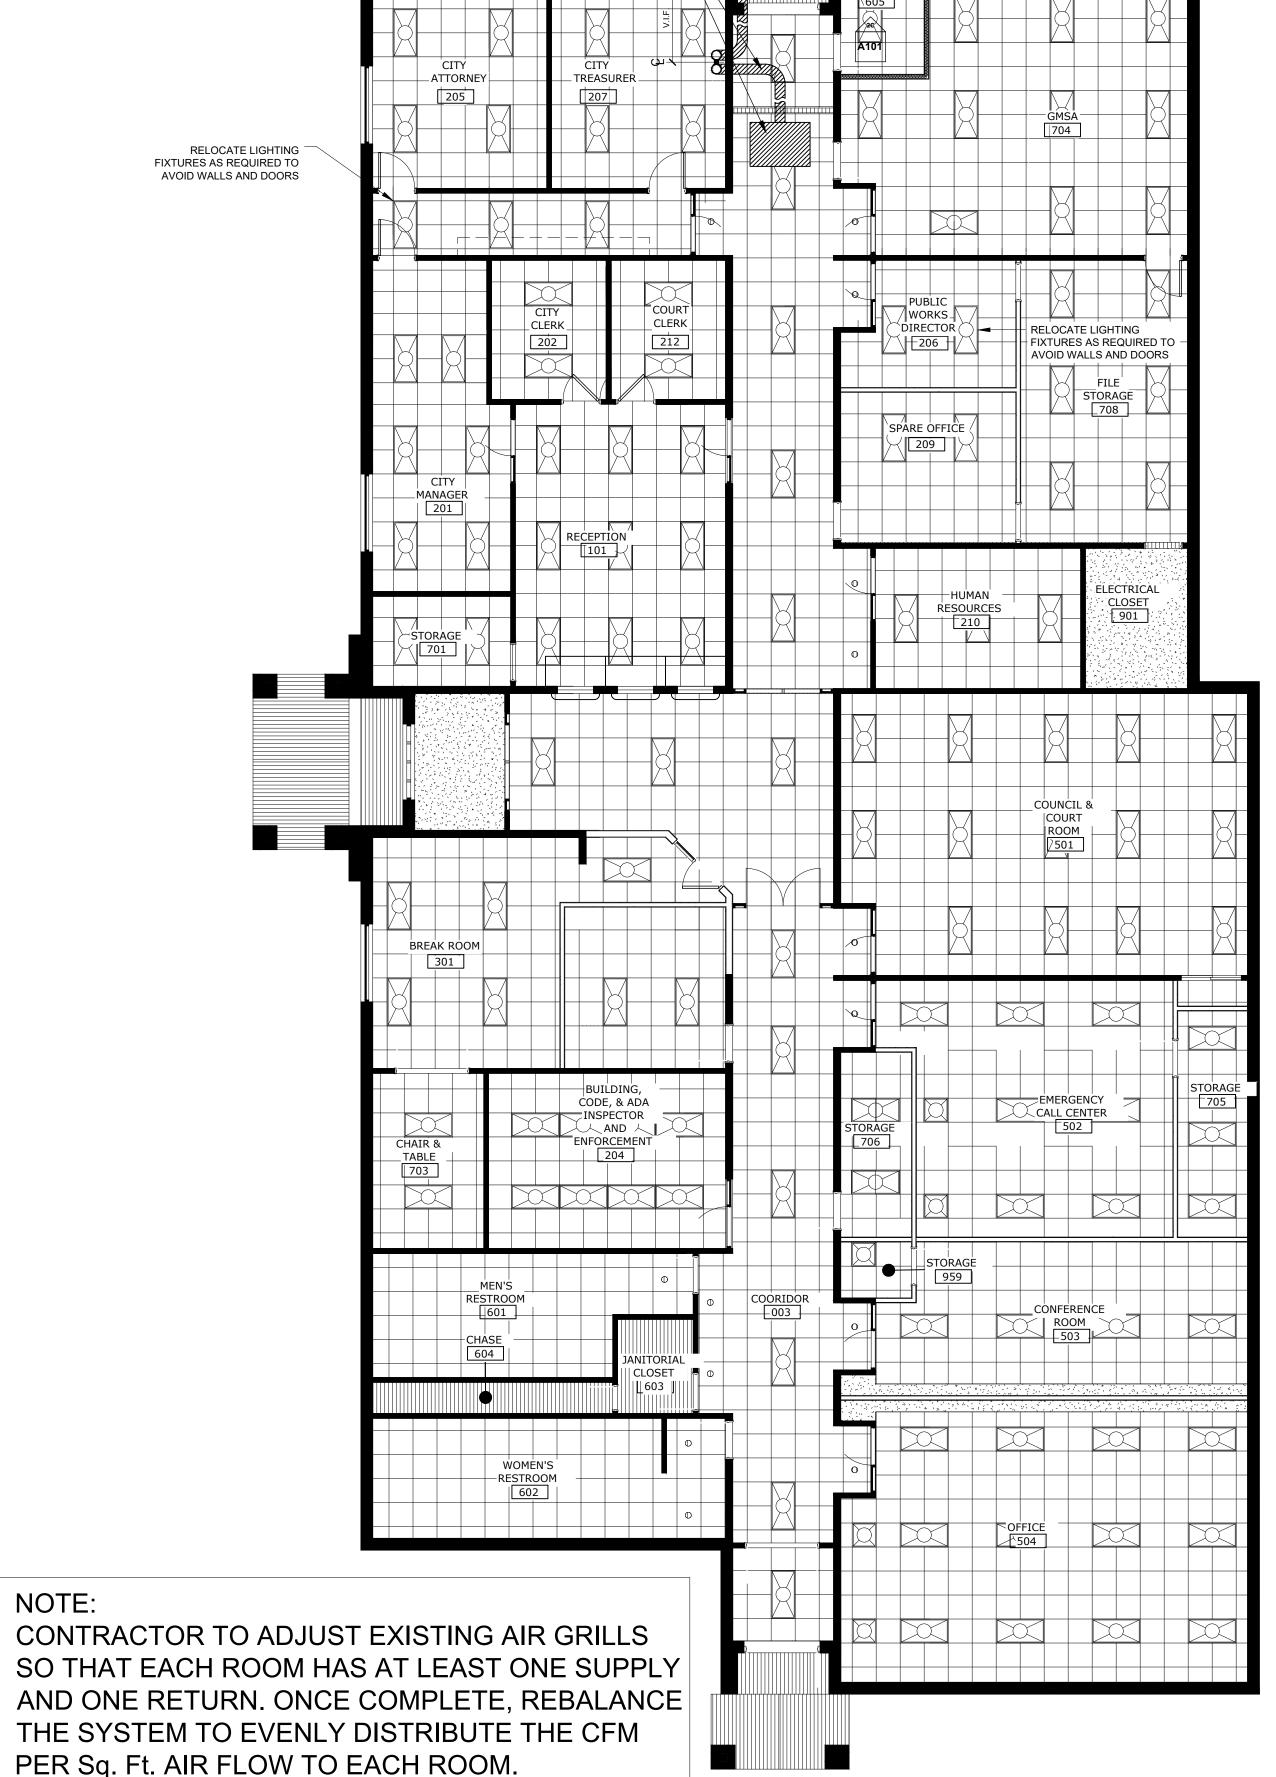

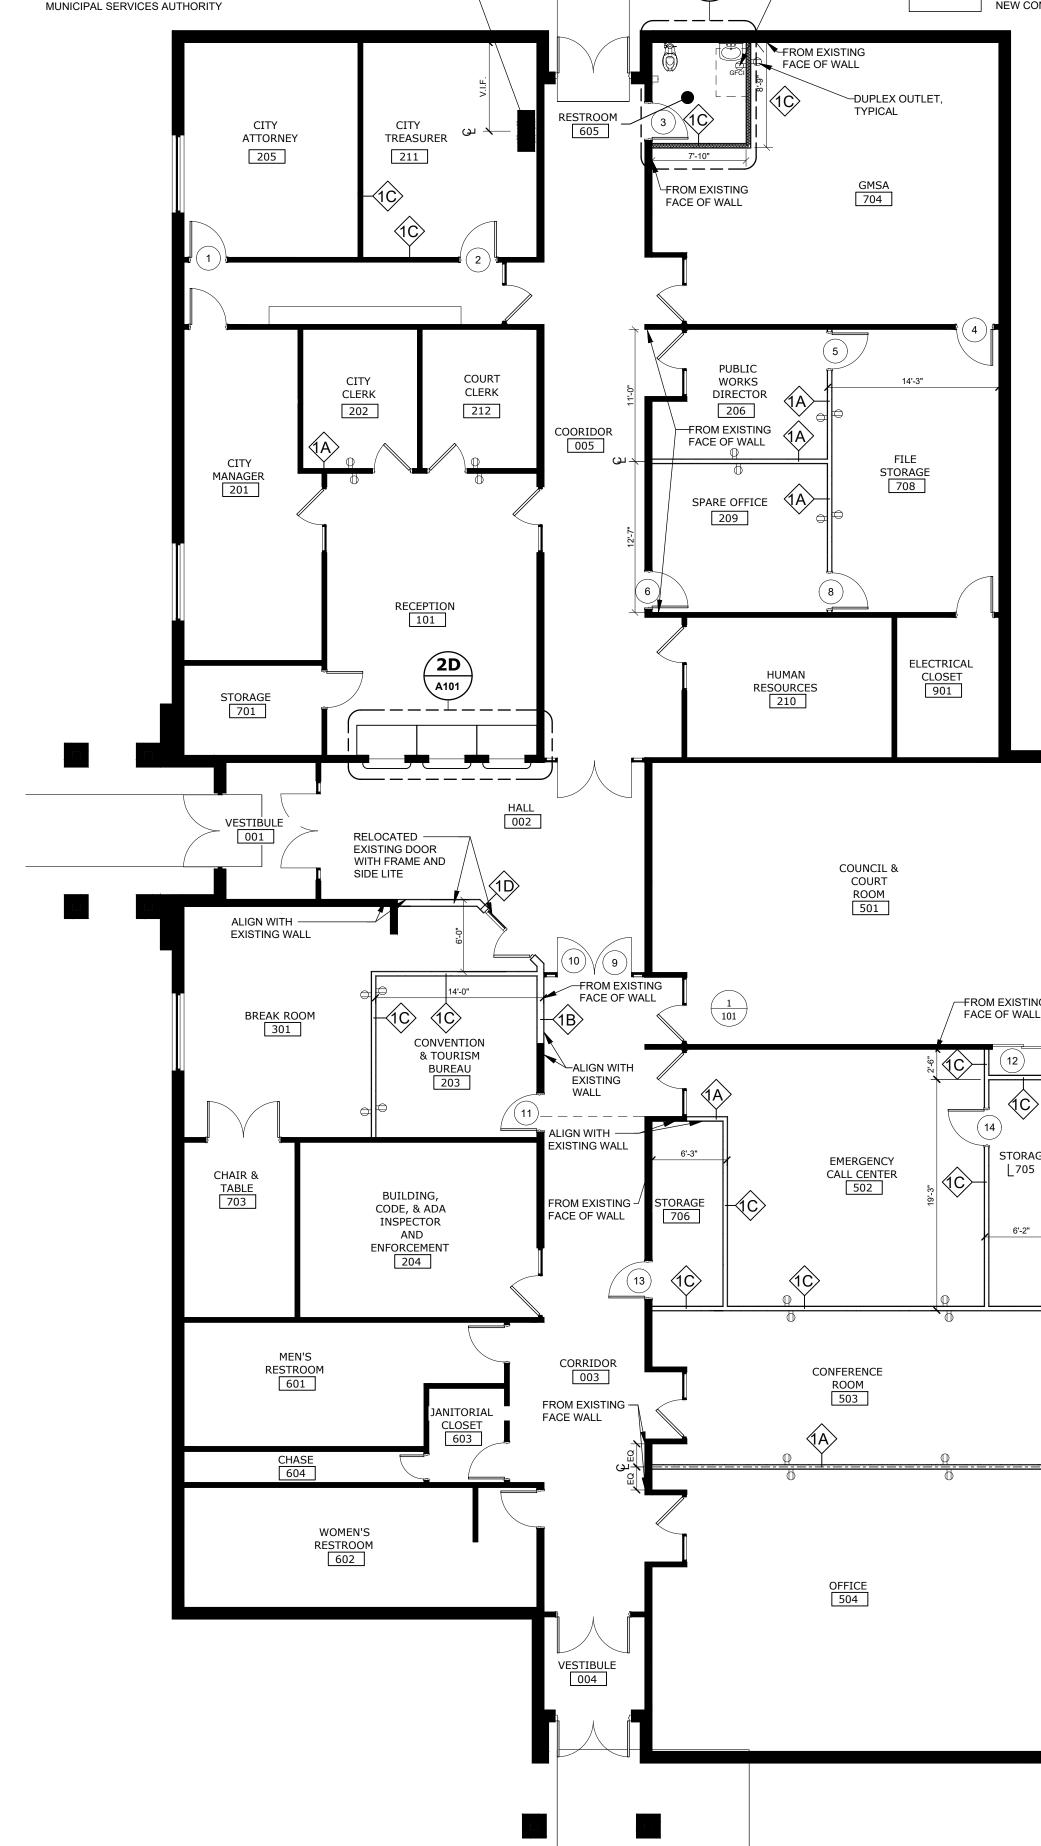


FLOOR PLAN
1/8" = 1'-0"
A101


REFLECTED CEILING PLAN


1/8" = 1'-0"


A101


A101

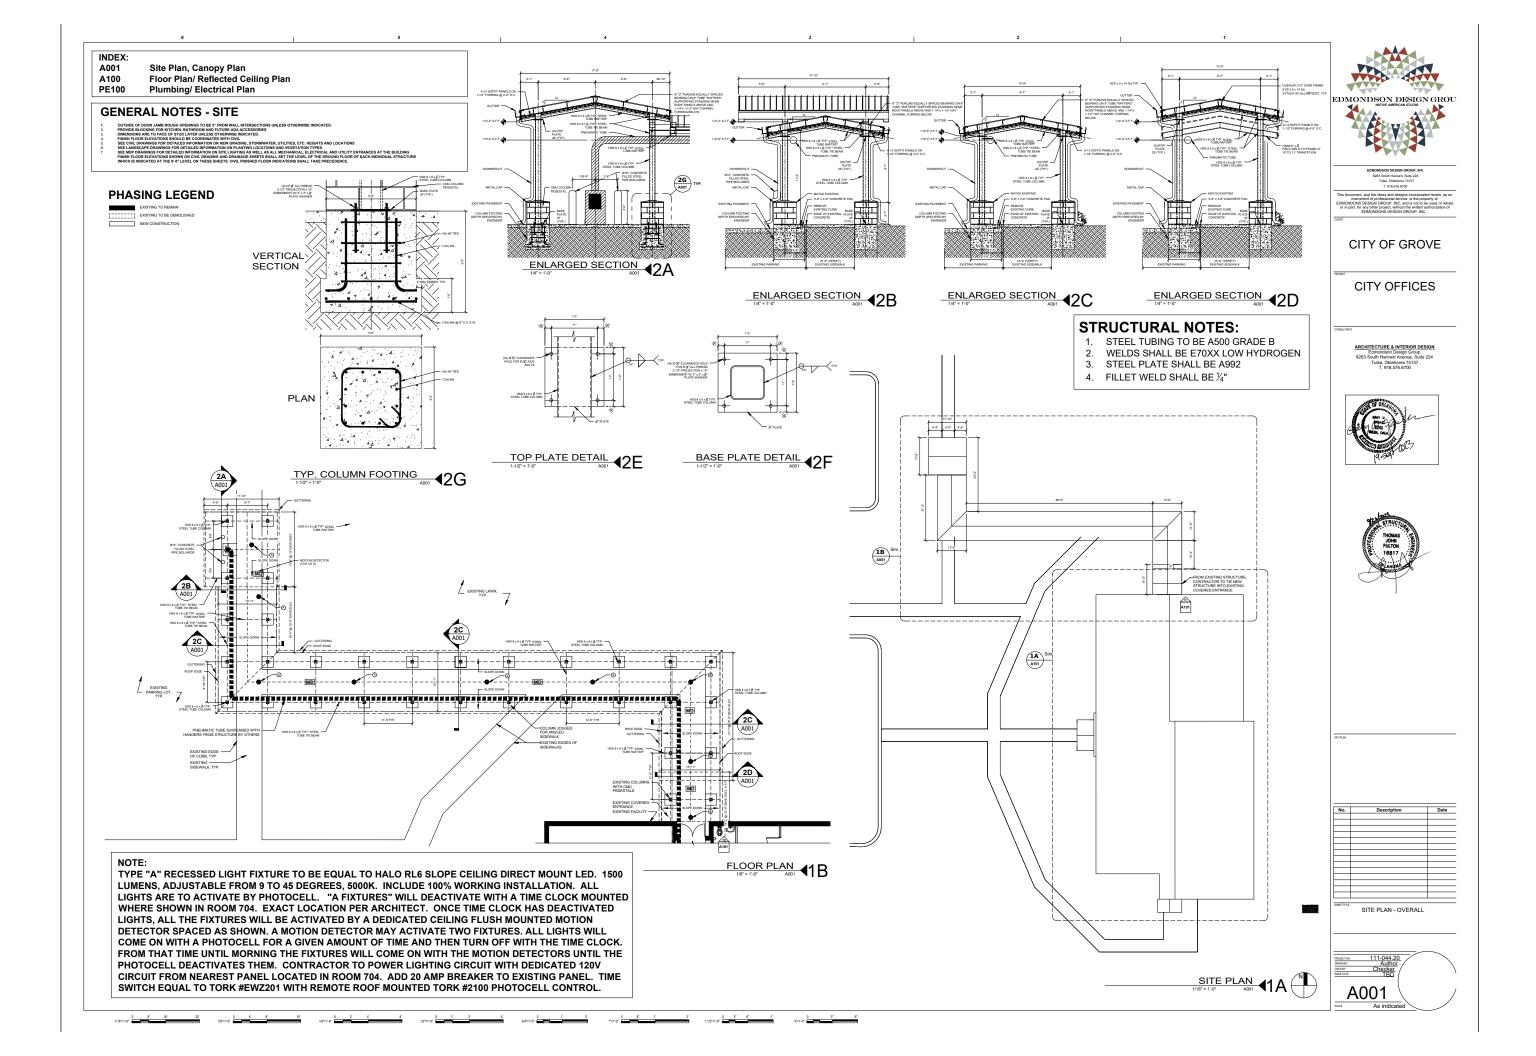

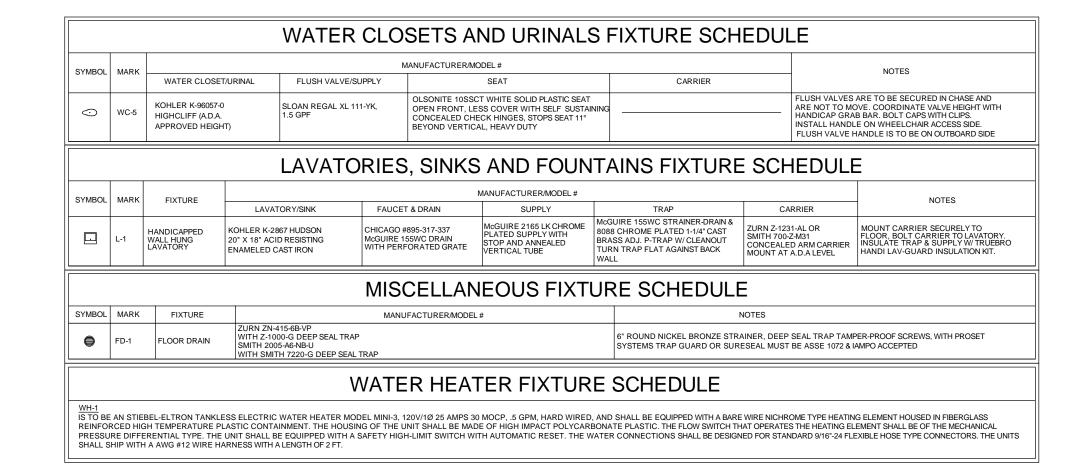

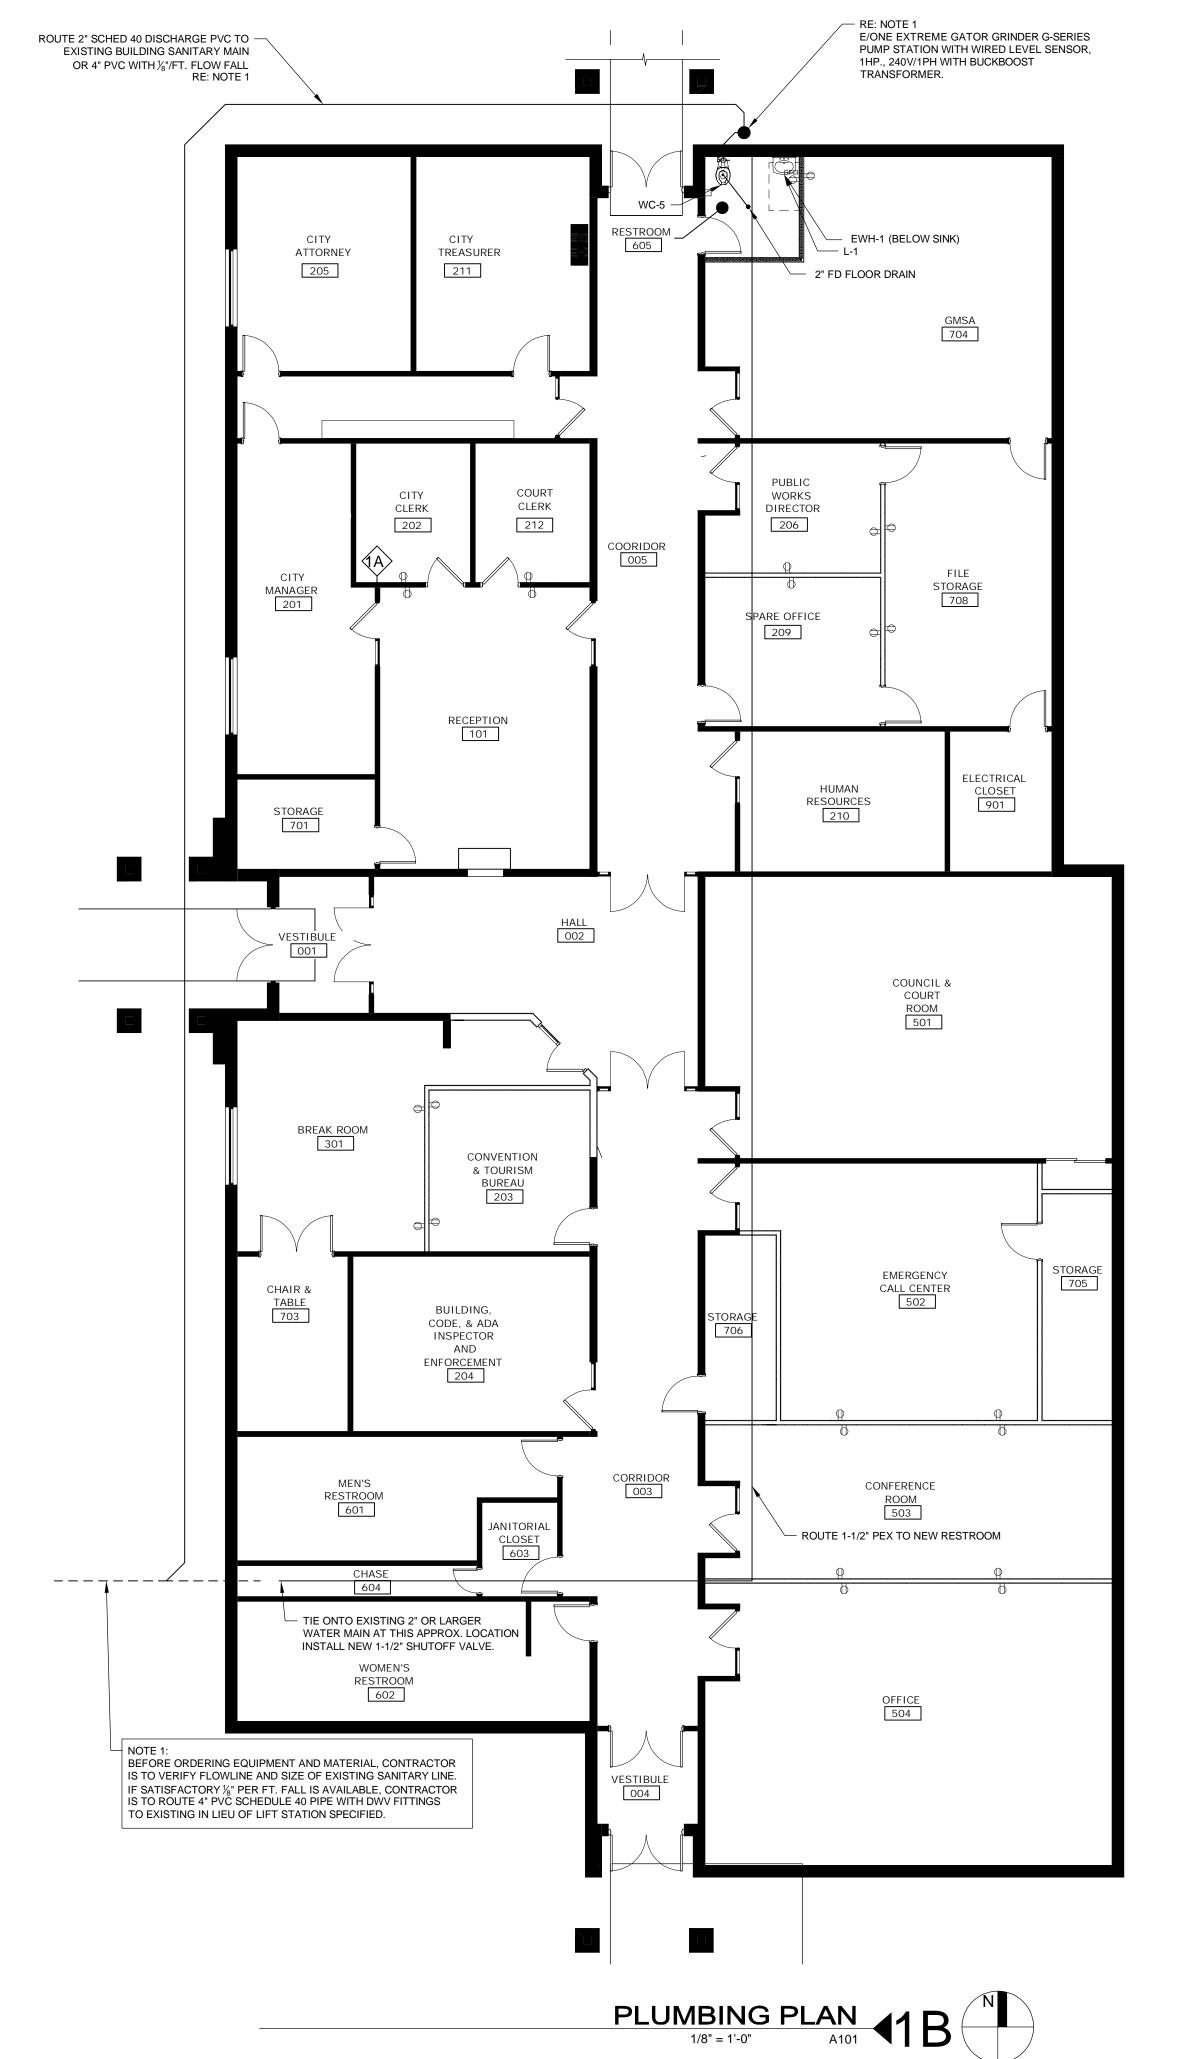

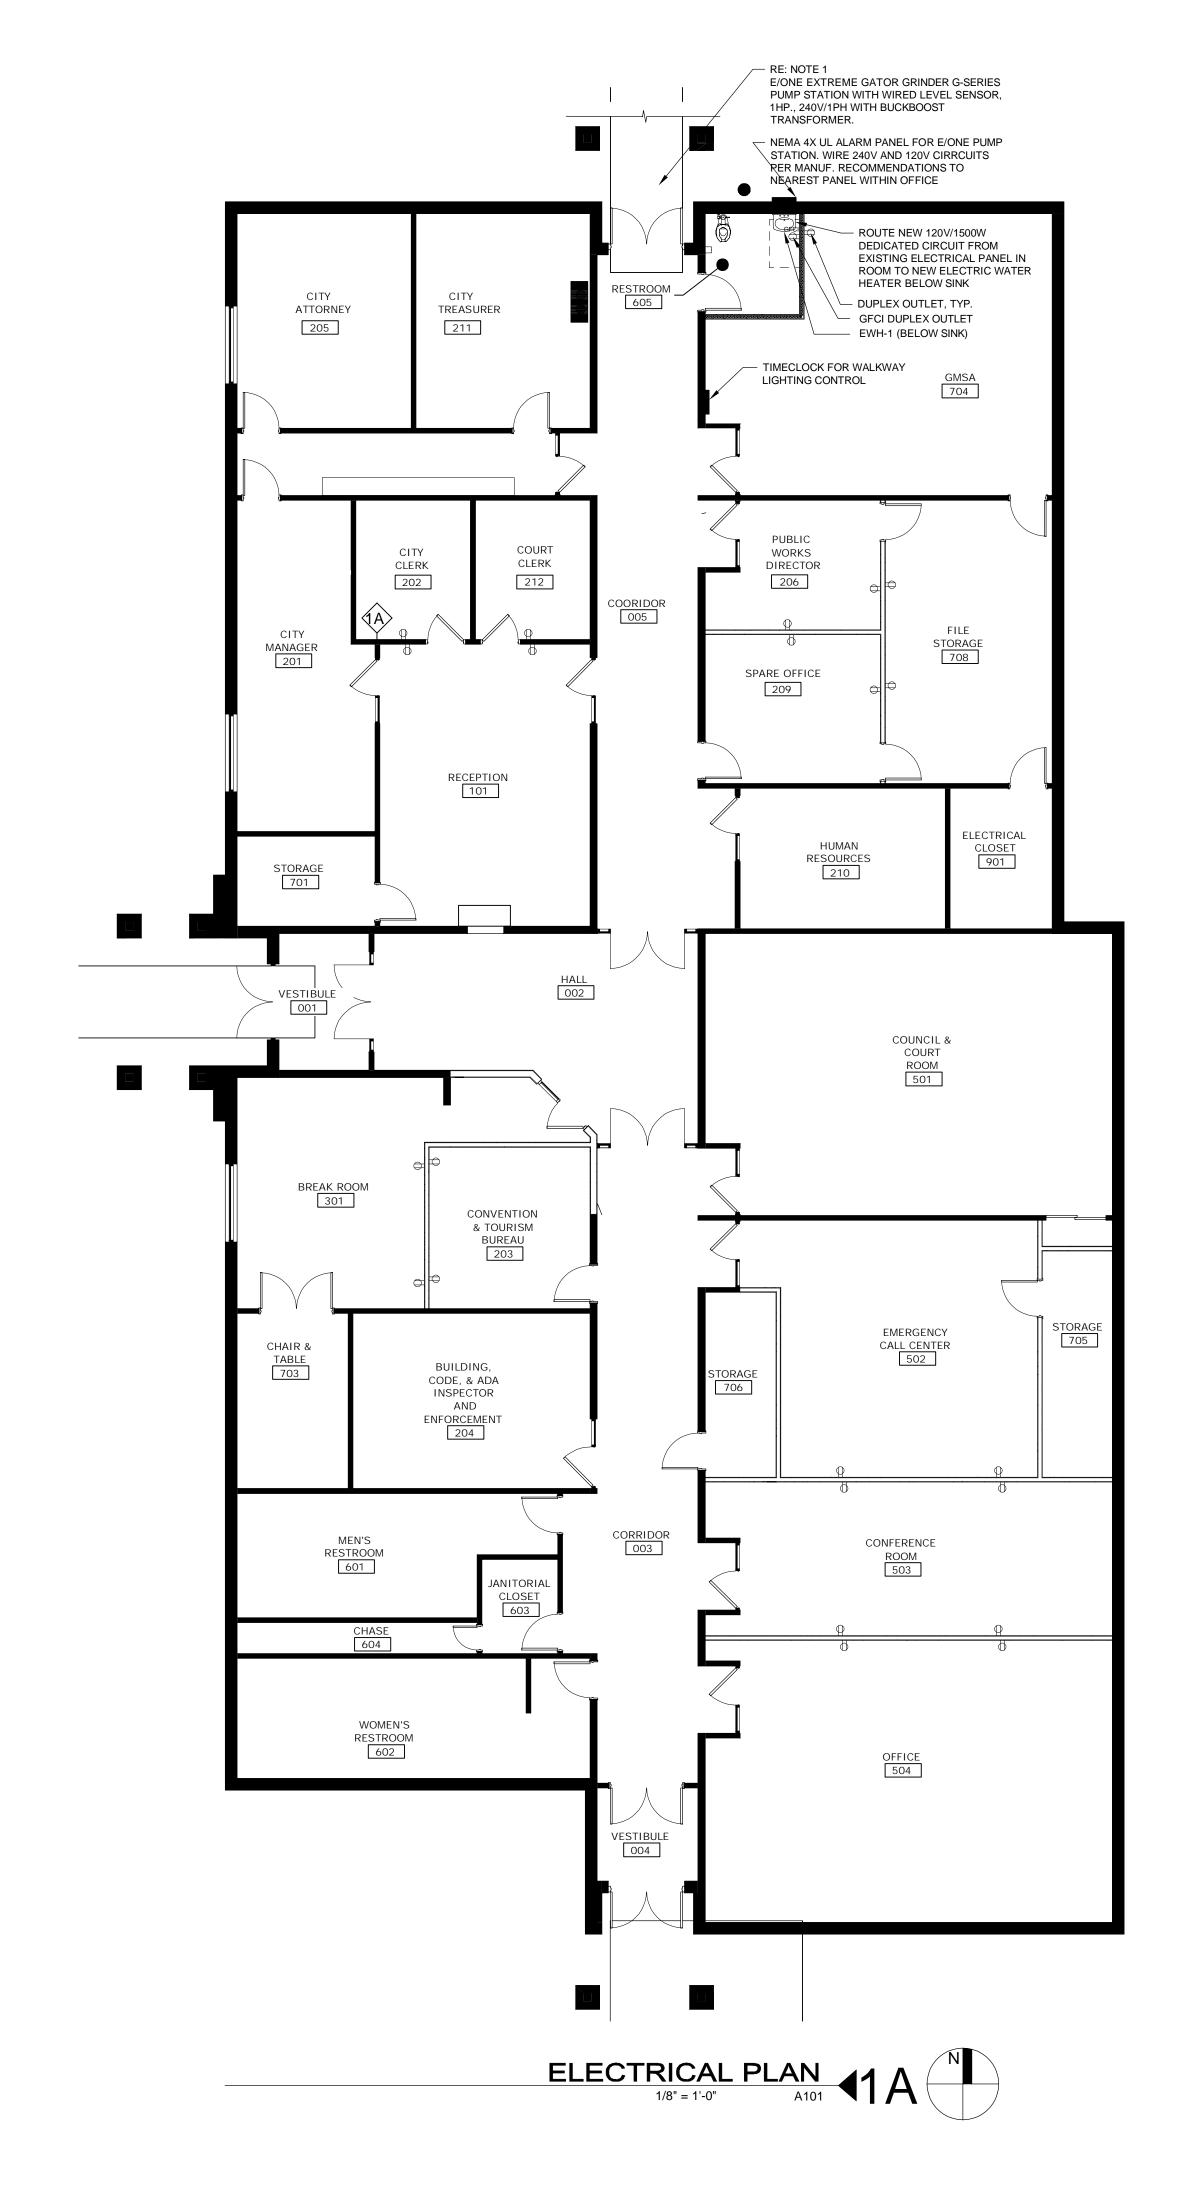

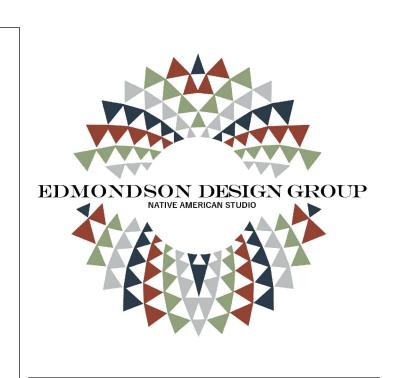

EDMONDSON DESIGN GROUP, INC. 8263 South Harvard, Suite 224 Tulsa, Oklahoma 74137 T: 918.576.6700

This document, and the ideas and designs incorporated herein, as an instrument of professional service, is the property of EDMONDONS DESIGN GROUP, INC. and is not to be used, in whole or in part, for any other project, without the written authorization of EDMONDONS DESIGN GROUP, INC. .

CITY OF GROVE

CITY OFFICES

0111 0111020

ARCHITECTURE & INTERIOR DESIGN

Edmondson Design Group

8263 South Harvard Avenue, Suite 224

Tulsa, Oklahoma 74137

T: 918.576.6700

No. Description Date

ELECTRICAL / PLUMBING PLAN

CONSTRUCTION DOCUMENTS

DRAWN BY:

CHKD BY:

ISSUE DATE:

TR

RC

TBD

Wesley

FANTAL AHONA

SCALE

As indicated

0 8' 16' 32' 0 4' 8' 16' 0 2' 4' 8' 0 1' 2' 4' 0 1' 2' 0 6" 1' 2' 0 3" 6" 1' 0 5"=1'-0" 1/2"=1'-0"